

### Case 2013

**Applicant**: CA Student Living

Owner: Same

**Request:** Site Plan Approval for Jackson Row

**Location:** 405 Jackson Avenue West

**Zoning:** (GB) General Business

**History:** Case #1683 Special Exception for Jackson Row

Case #1684 Site Plan Approval for Jackson Row

Case #1948 Special Exception for Jackson Row (renewal)

Case #2012 Special Exception for Jackson Row

## **Surrounding Zoning and Uses:**

North: (GB) General Business – Christ Church Temple, James Food Center

**South**: (RB) Two-Unit Residential – Residences (single and multi)

East: (GB) General Business - Adelaide Place Condominiums and Star Package

West: (GB) General Business – Rental Property

### **Planner's Comments:**

The applicant is seeking a site plan approval for the Jackson Row project. The subject property is approximately +/- 41,469 square feet or .95 acres located to the south of Jackson Avenue West and east of South 6<sup>th</sup> Street. The property slopes steadily downward from South 6<sup>th</sup> Street to Adelaide Place and the elevation between the subject property and the property to the south along Van Buren is considerable. General Business uses along with two churches have been in existence and occupying the length of this portion of Jackson Avenue since the early 1900's.


The applicant is proposing to build a 5 story, +/- 110,411 square feet building and includes 10,600 square feet of commercial space. The residential portion of the development contains 69 units, 224 beds and 232 underground parking spaces. Oxford's Conservation Overlay district requires that impervious surfaces not exceed 60% of the lot area. In addition to the green space provided around the perimeter and the rear of the site, the applicant is proposing a green roof on the building. The building plans submitted for review have been determined to be compliant with

Oxford's height ordinance by the Building Department and Public Works. The Storm Water Detention Management Report for Jackson Row, submitted 10/21/15, is accepted and approved.

The applicant's site plan has been before the site plan review committee on numerous occasions and received final approval on 10/28/2015. All revisions have been made for compliance.

**Recommendation:** Approve the site plan for 'Jackson Row,' a mixed-use development with the following conditions:

- 1. There will be no on-street parking allowed on South 6<sup>th</sup> Street, adjacent to this property and the applicant will paint the curb yellow.
- 2. Non-parking areas will be the owner's responsibility to enforce.
- 3. Approval is for the site plan as submitted.

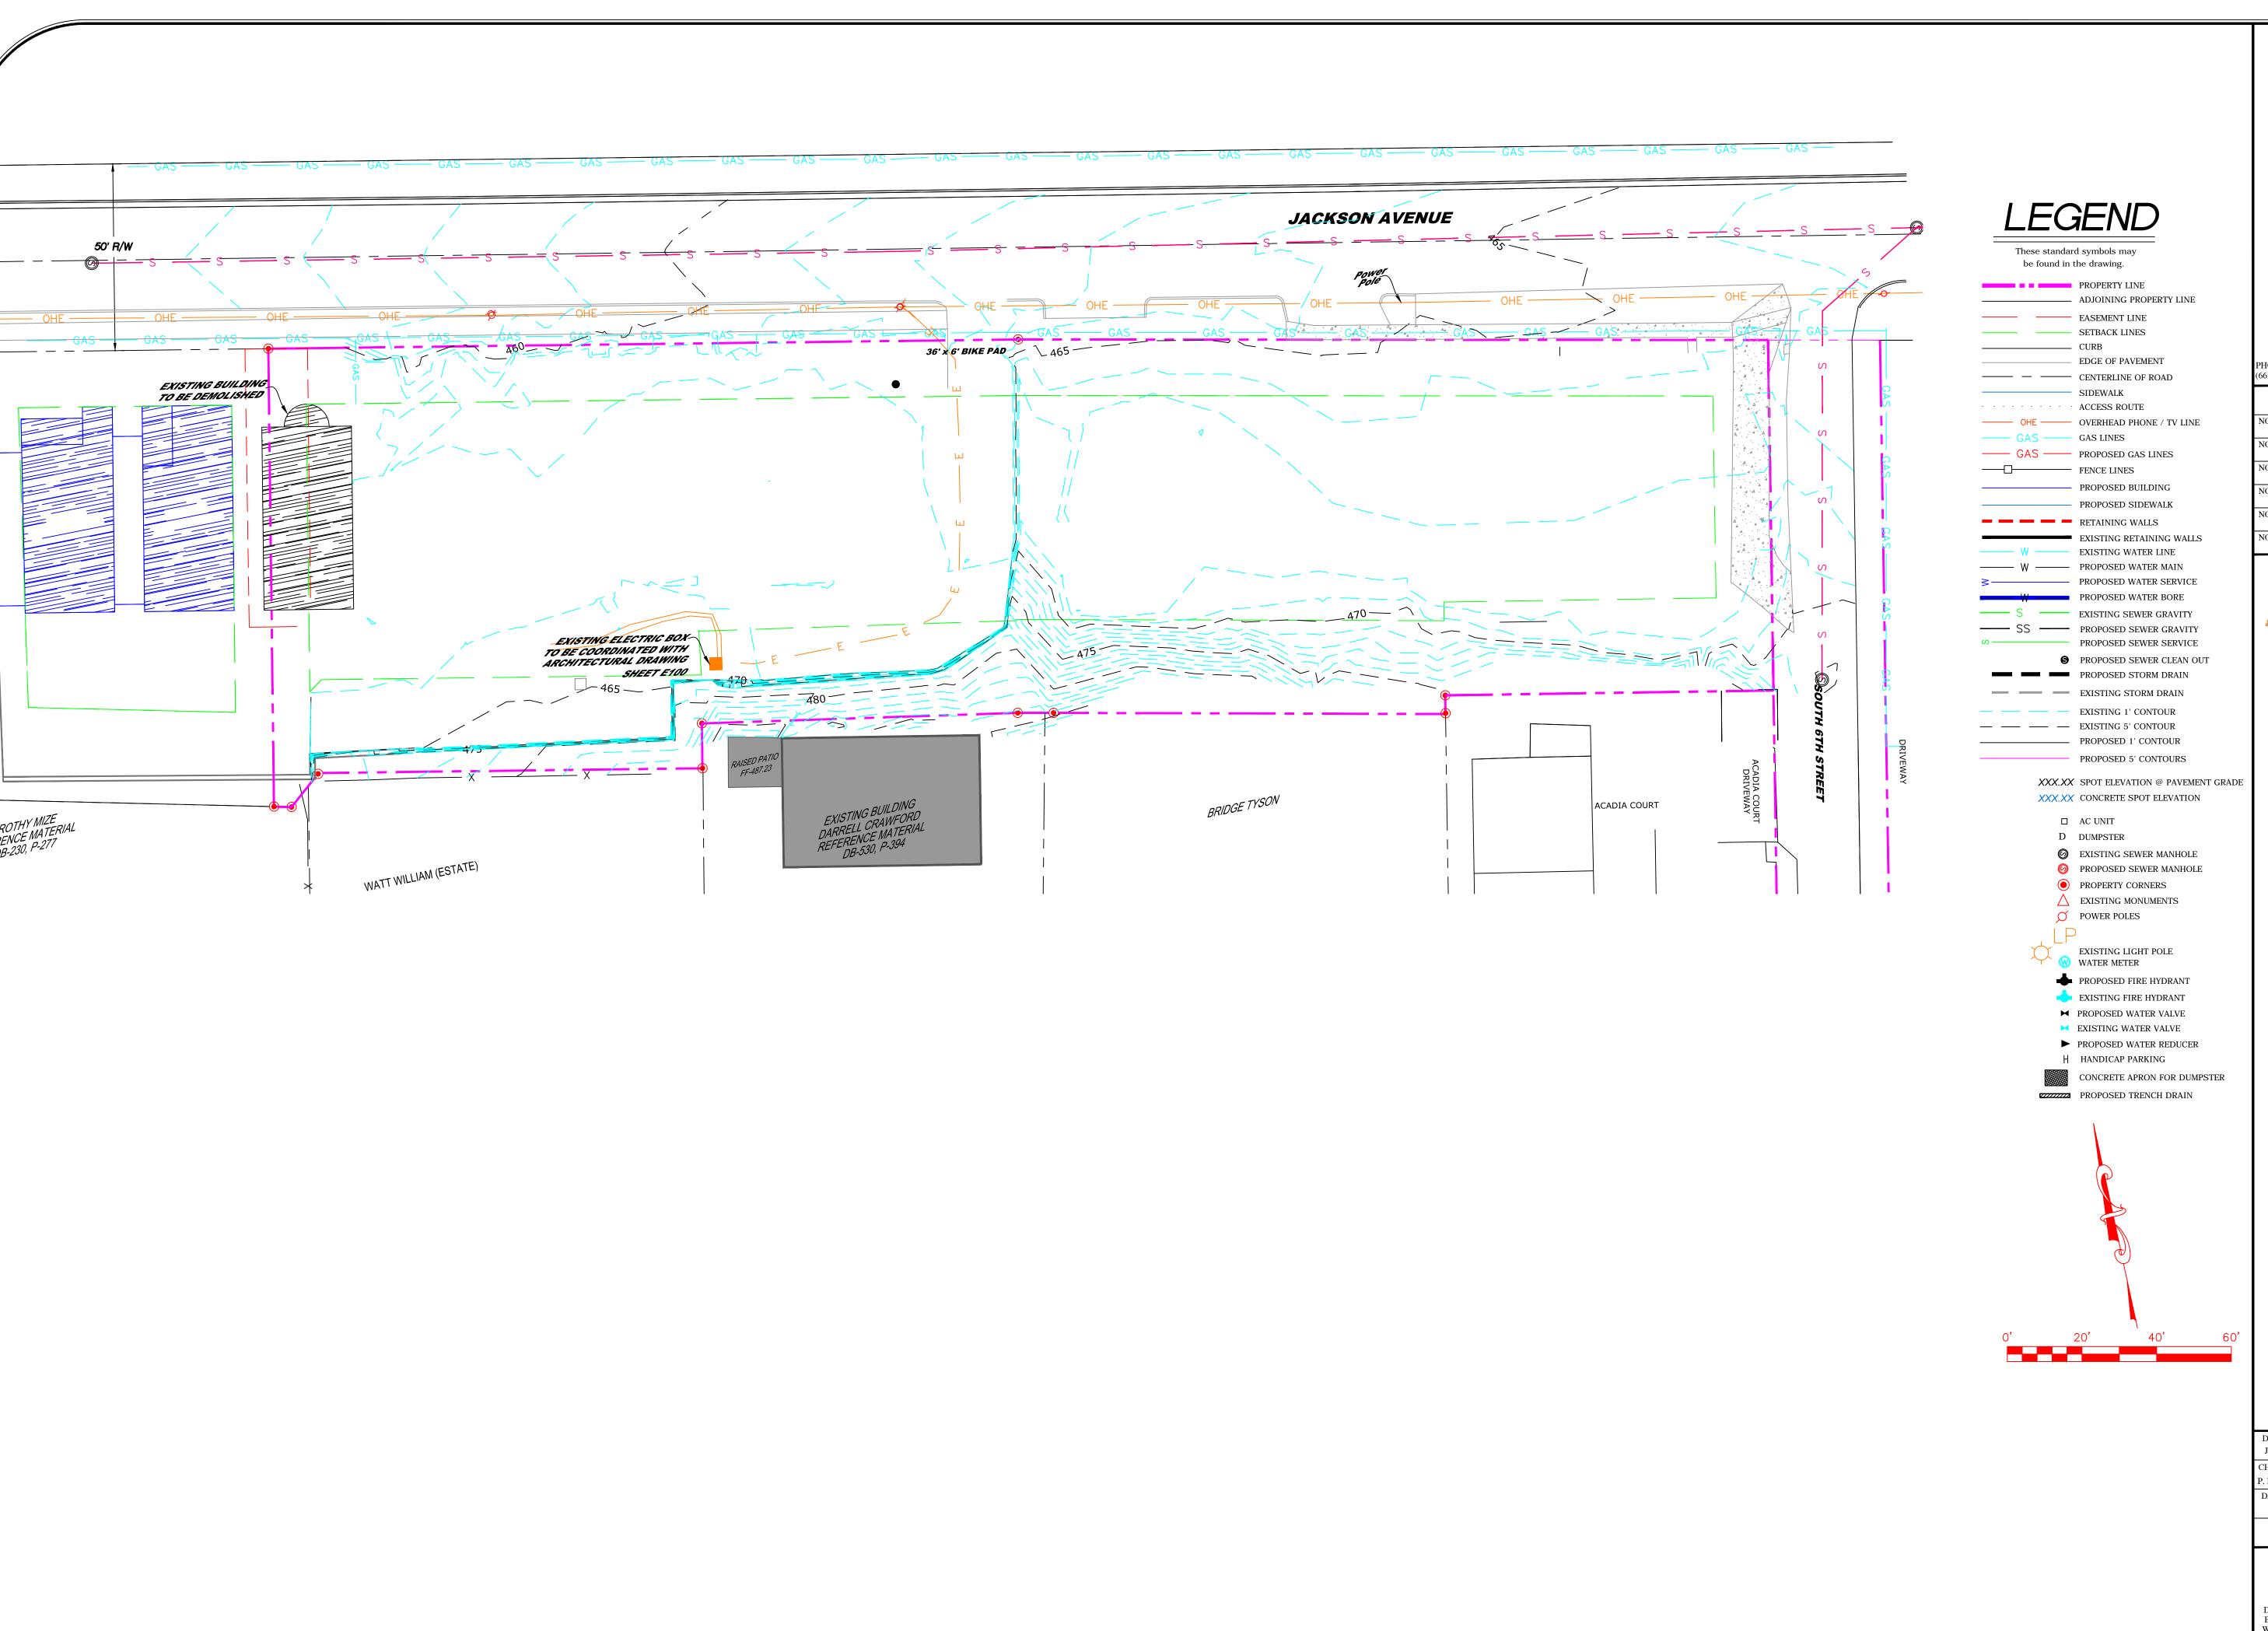




PHONE: (662) 234-8539		EMAIL: OXFORD@PECORPMS.COM WEB SITE: PECORPMS.COM	M FAX (662) 234-863
		REVISIONS	•
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DRAWN BY: J. WILSON	DATE: 10/28/2015
CHECKED BY:	SCALE: 1"=20'
P. KOSHENINA, P.E. DRAWING NO.:	1 =20
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(N-C) NEIGHBORHOOD CONSERVATION OVERLAY DISTRICT

15 FEET

10 FEET

25 FEET

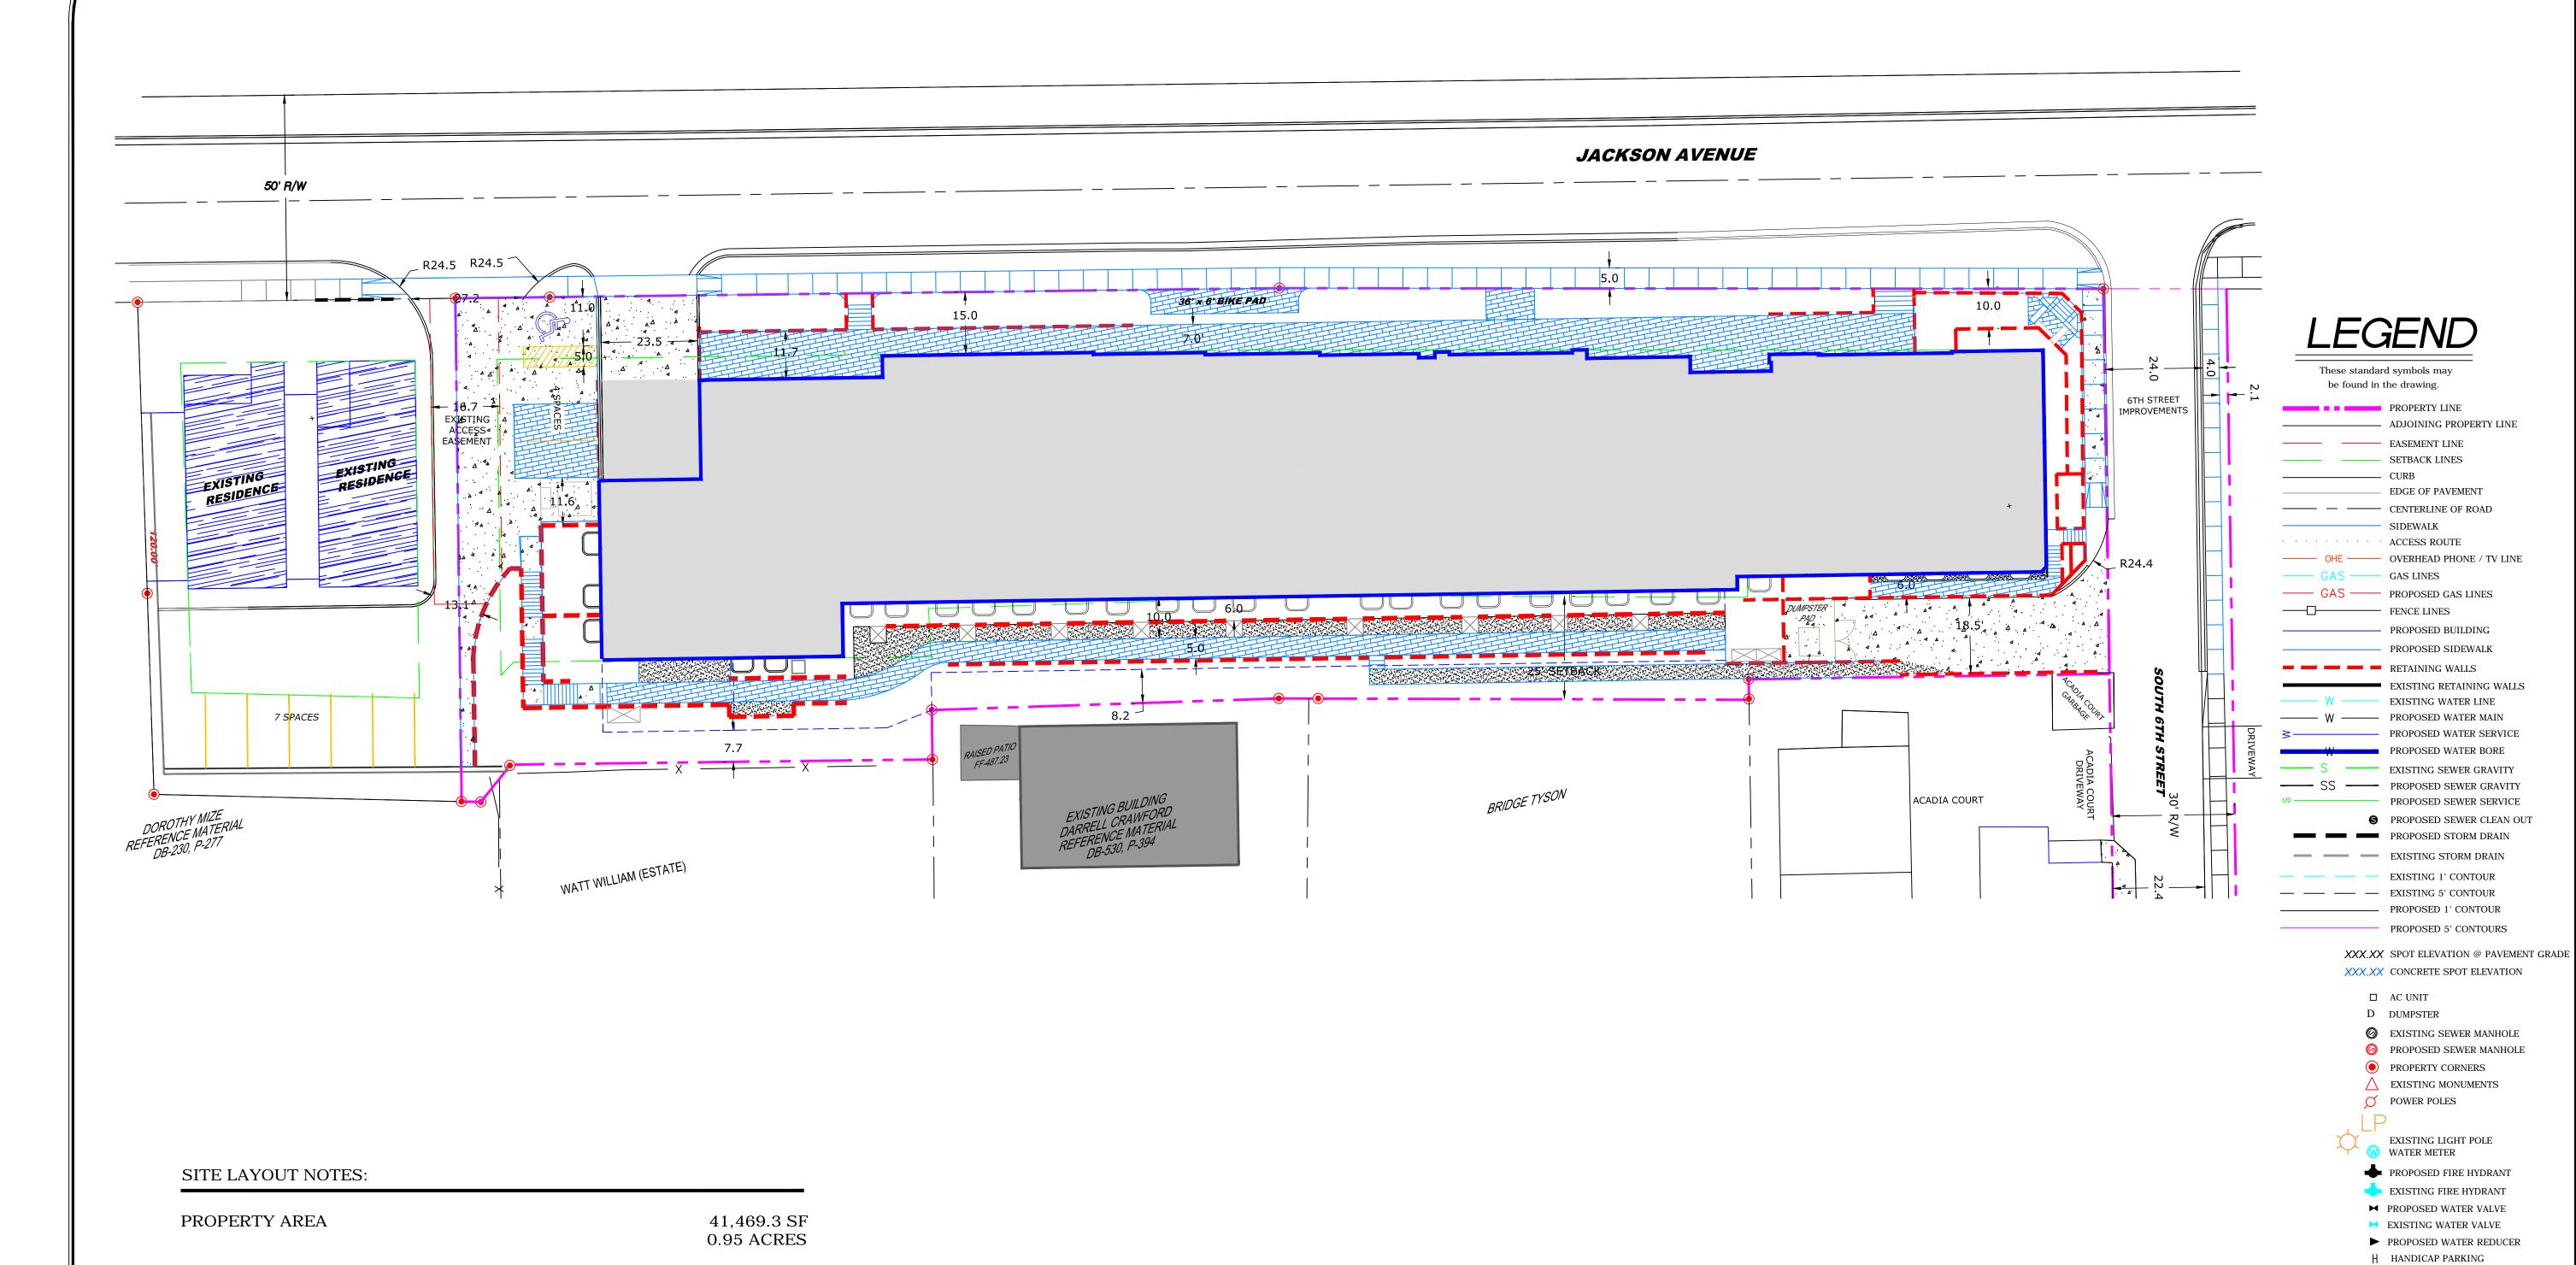SETBACKS FRONT

SIDE

REAR



PHONE: (662) 234-8539 (662) 234-8639

**REVISIONS:** NO.: DATE: REVISIONS: NO.: DATE: REVISIONS: NO.: DATE: REVISIONS:



DATE: 10/28/2015 J. WILSON CHECKED BY: P. KOSHENINA, P.E. DRAWING NO.:


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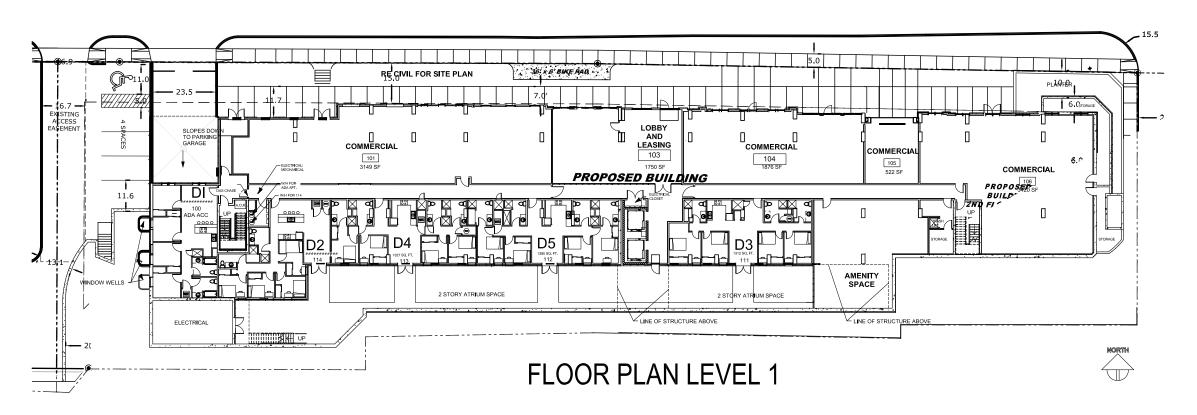
CONCRETE APRON FOR DUMPSTER


PROPOSED TRENCH DRAIN

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**PARKING LEVEL 1** 


GROUND LEVEL: 4 SPACES LEVEL 1 PARKING GARAGE: 74 SPACES **76 SPACES** LEVEL PARKING GARAGE: LEVEL 3 PARKING GARAGE: 77 SPACES TOTAL PARKING SPACES: 231 SPACES



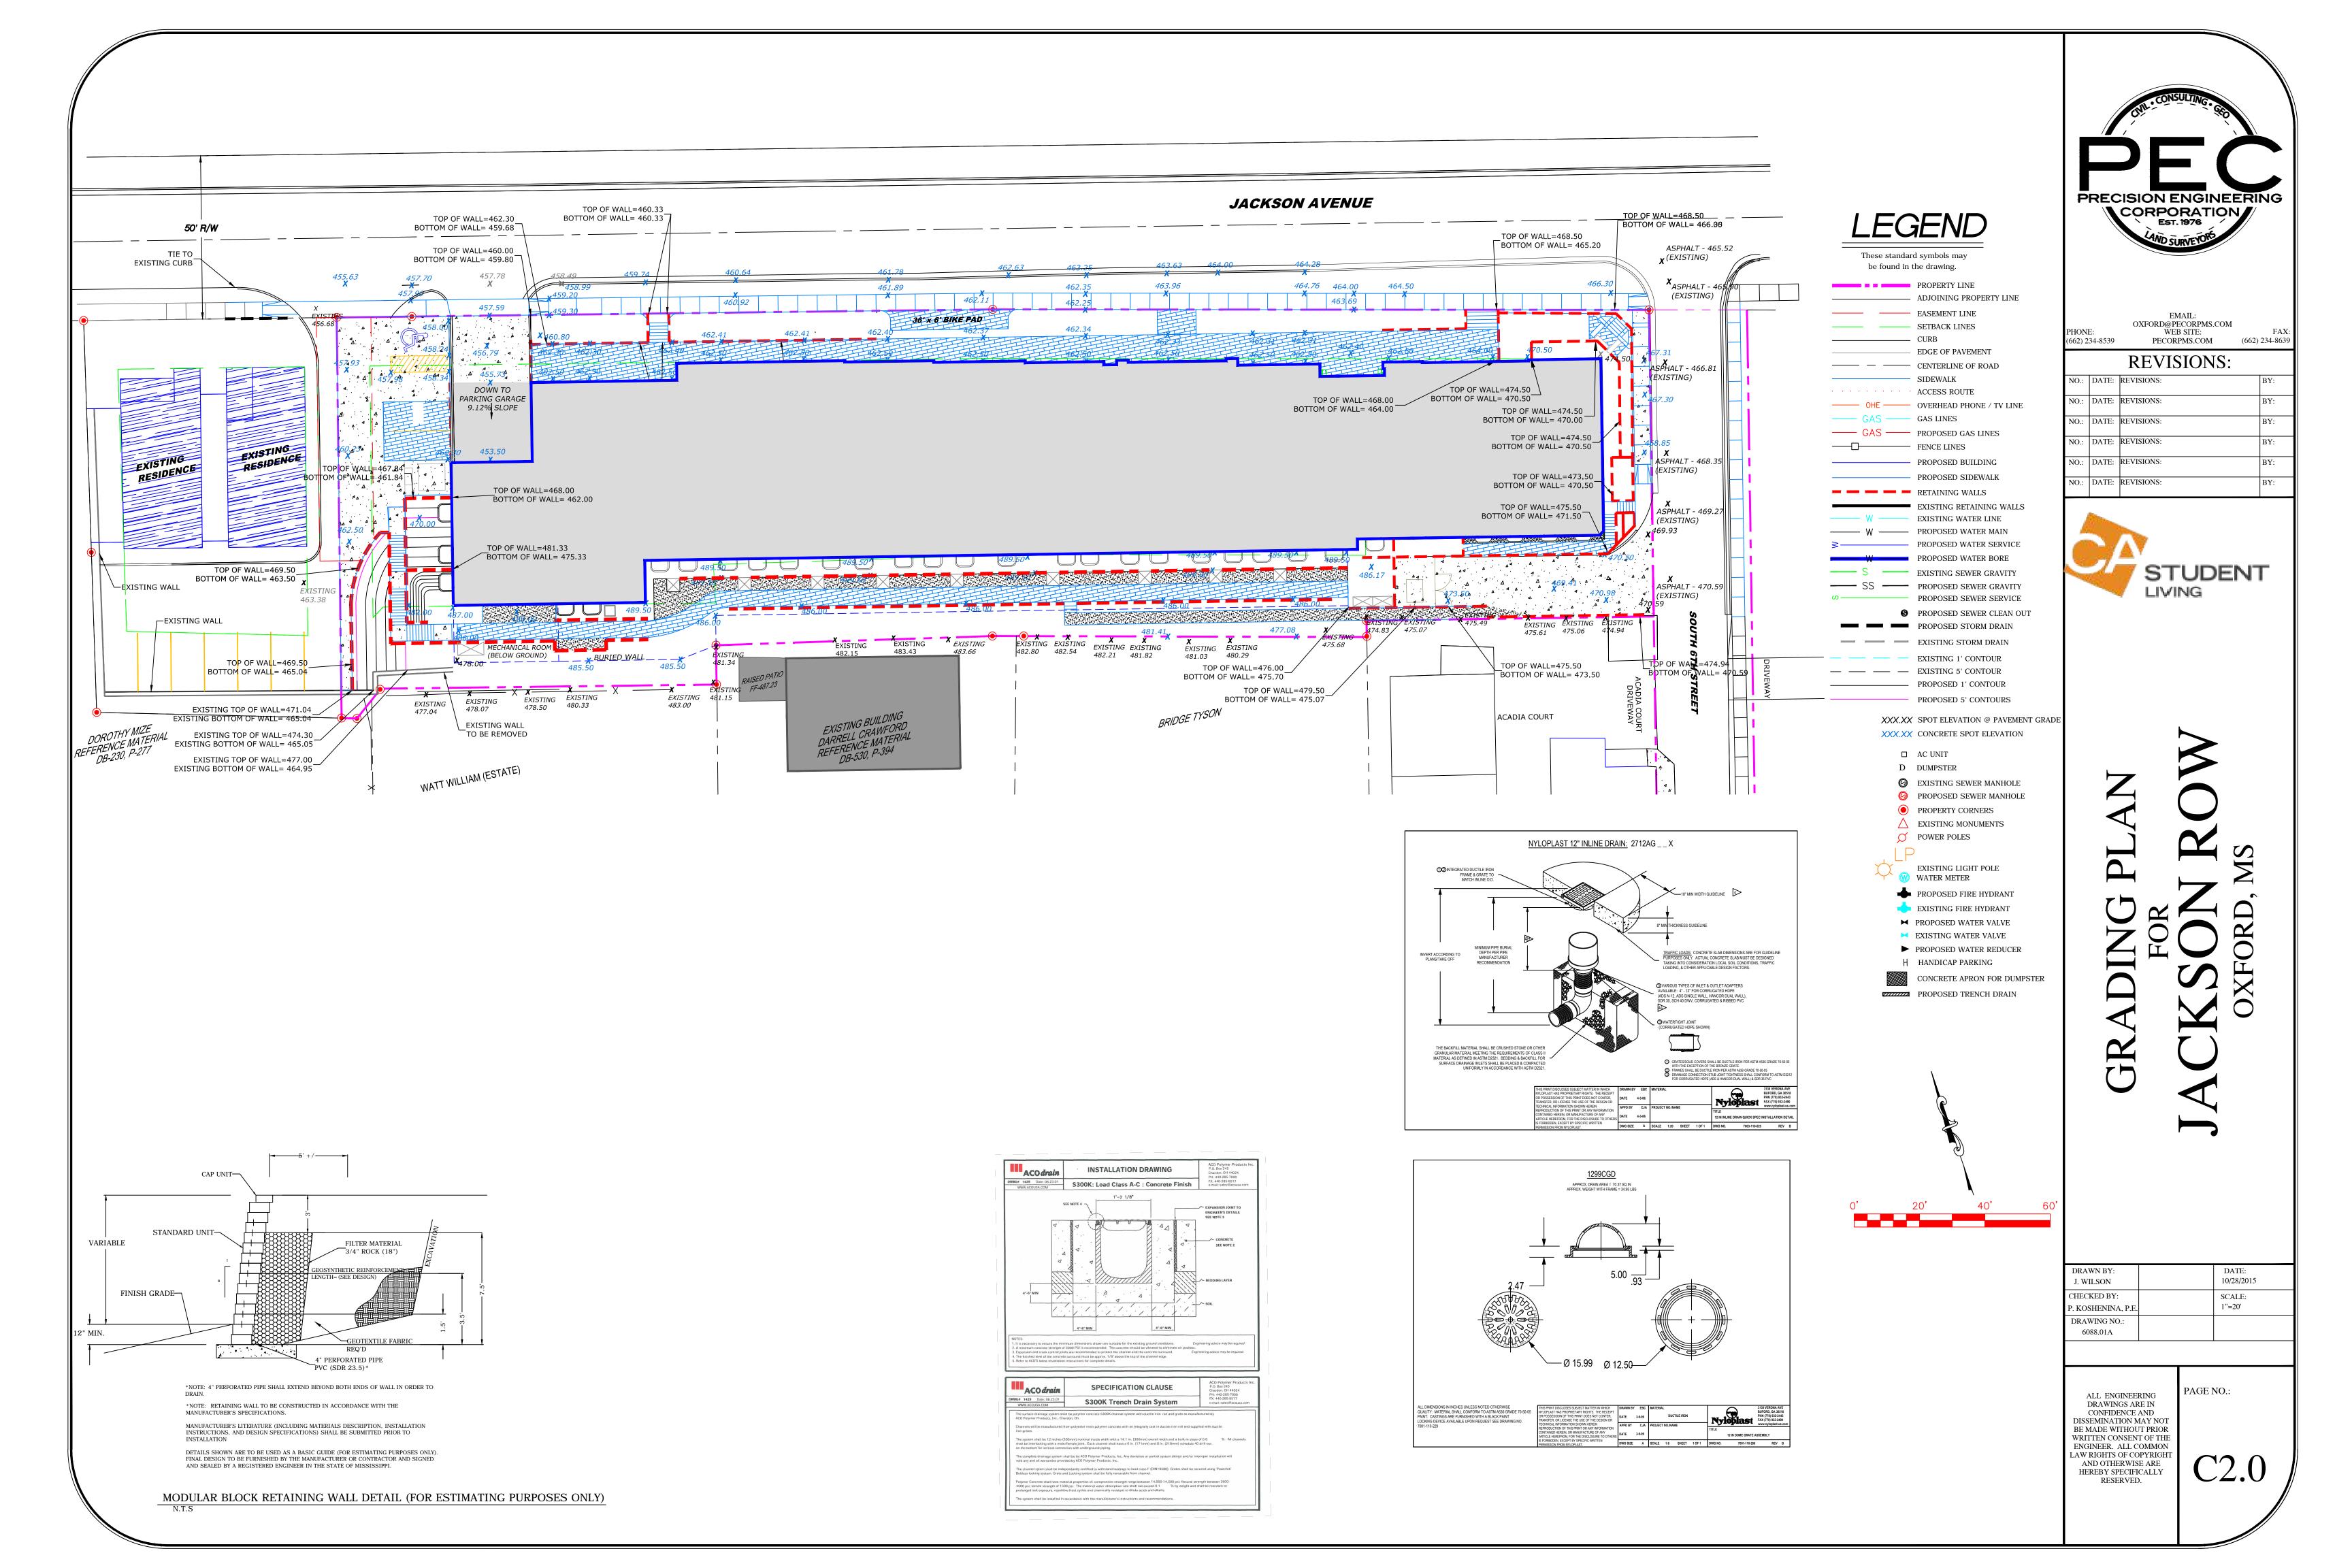

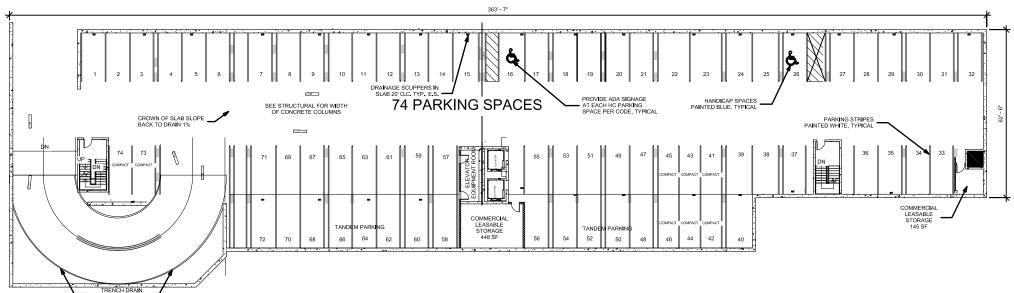
2014 by **HUMPHREYS** & **PARTNERS** ARCHITECTS, LP he arrangements deplcted herein Architectural conceptual site plans are for feasibility purpose

Oct 13, 2015

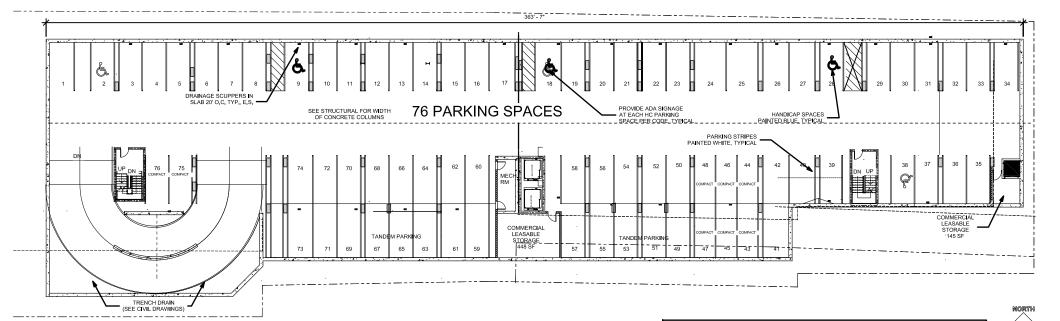

# PARKING LEVEL 2

GROUND LEVEL: 4 SPACES 74 SPACES LEVEL 1 PARKING GARAGE: LEVEL PARKING GARAGE: **76 SPACES** LEVEL 3 PARKING GARAGE: 77 SPACES TOTAL PARKING SPACES: 231 SPACES

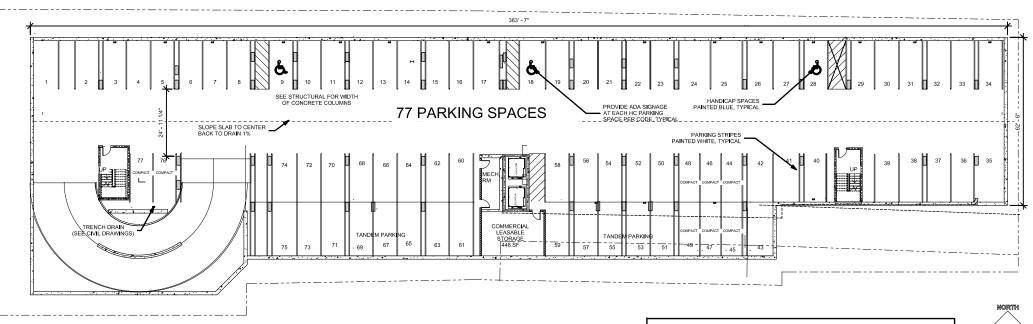

PARKING LEVEL 3

GROUND LEVEL: 4 SPACES LEVEL 1 PARKING GARAGE: 74 SPACES LEVEL PARKING GARAGE: **76 SPACES** LEVEL 3 PARKING GARAGE: 77 SPACES TOTAL PARKING SPACES: 231 SPACES

410 SCALE: 3/32" = 1'-0" (24"x36" SHEET)

**JACKSON ROW CA VENTURES** OXFORD, MS







EAST ELEVATION

# NORTH ELEVATION

**BUILDING ELEVATIONS** 

HPA#15435

TORONTO EDMONTON MONTEVIDEO DUBAI HANOI




**BUILDING ELEVATIONS** 

JACKSON ROW
CA VENTURES
OXFORD, MS



TORONTO EDMONTON MONTEVIDEO DUBAI HANOI

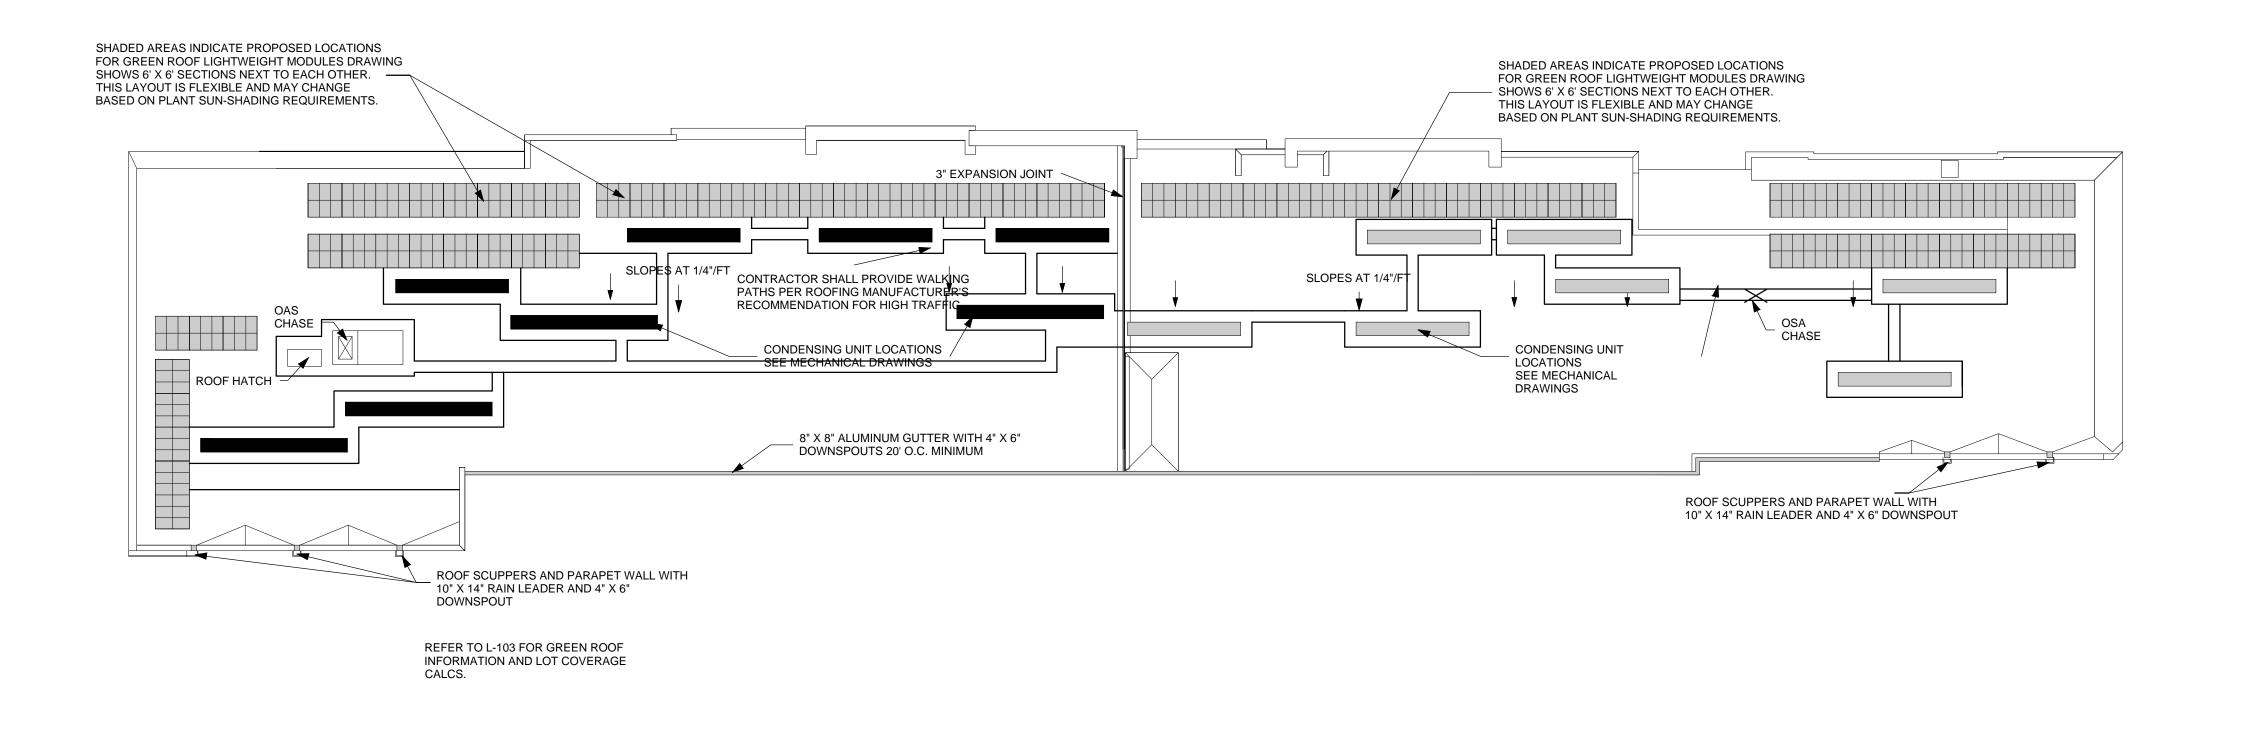


SCALE: 1/16" = 1'-0" (24"x36" SHEET)

**ROOF PLAN** 

A 405

Oct 28, 2015

HUMPHREYS & PARTNERS ARCHITECTS L.P.

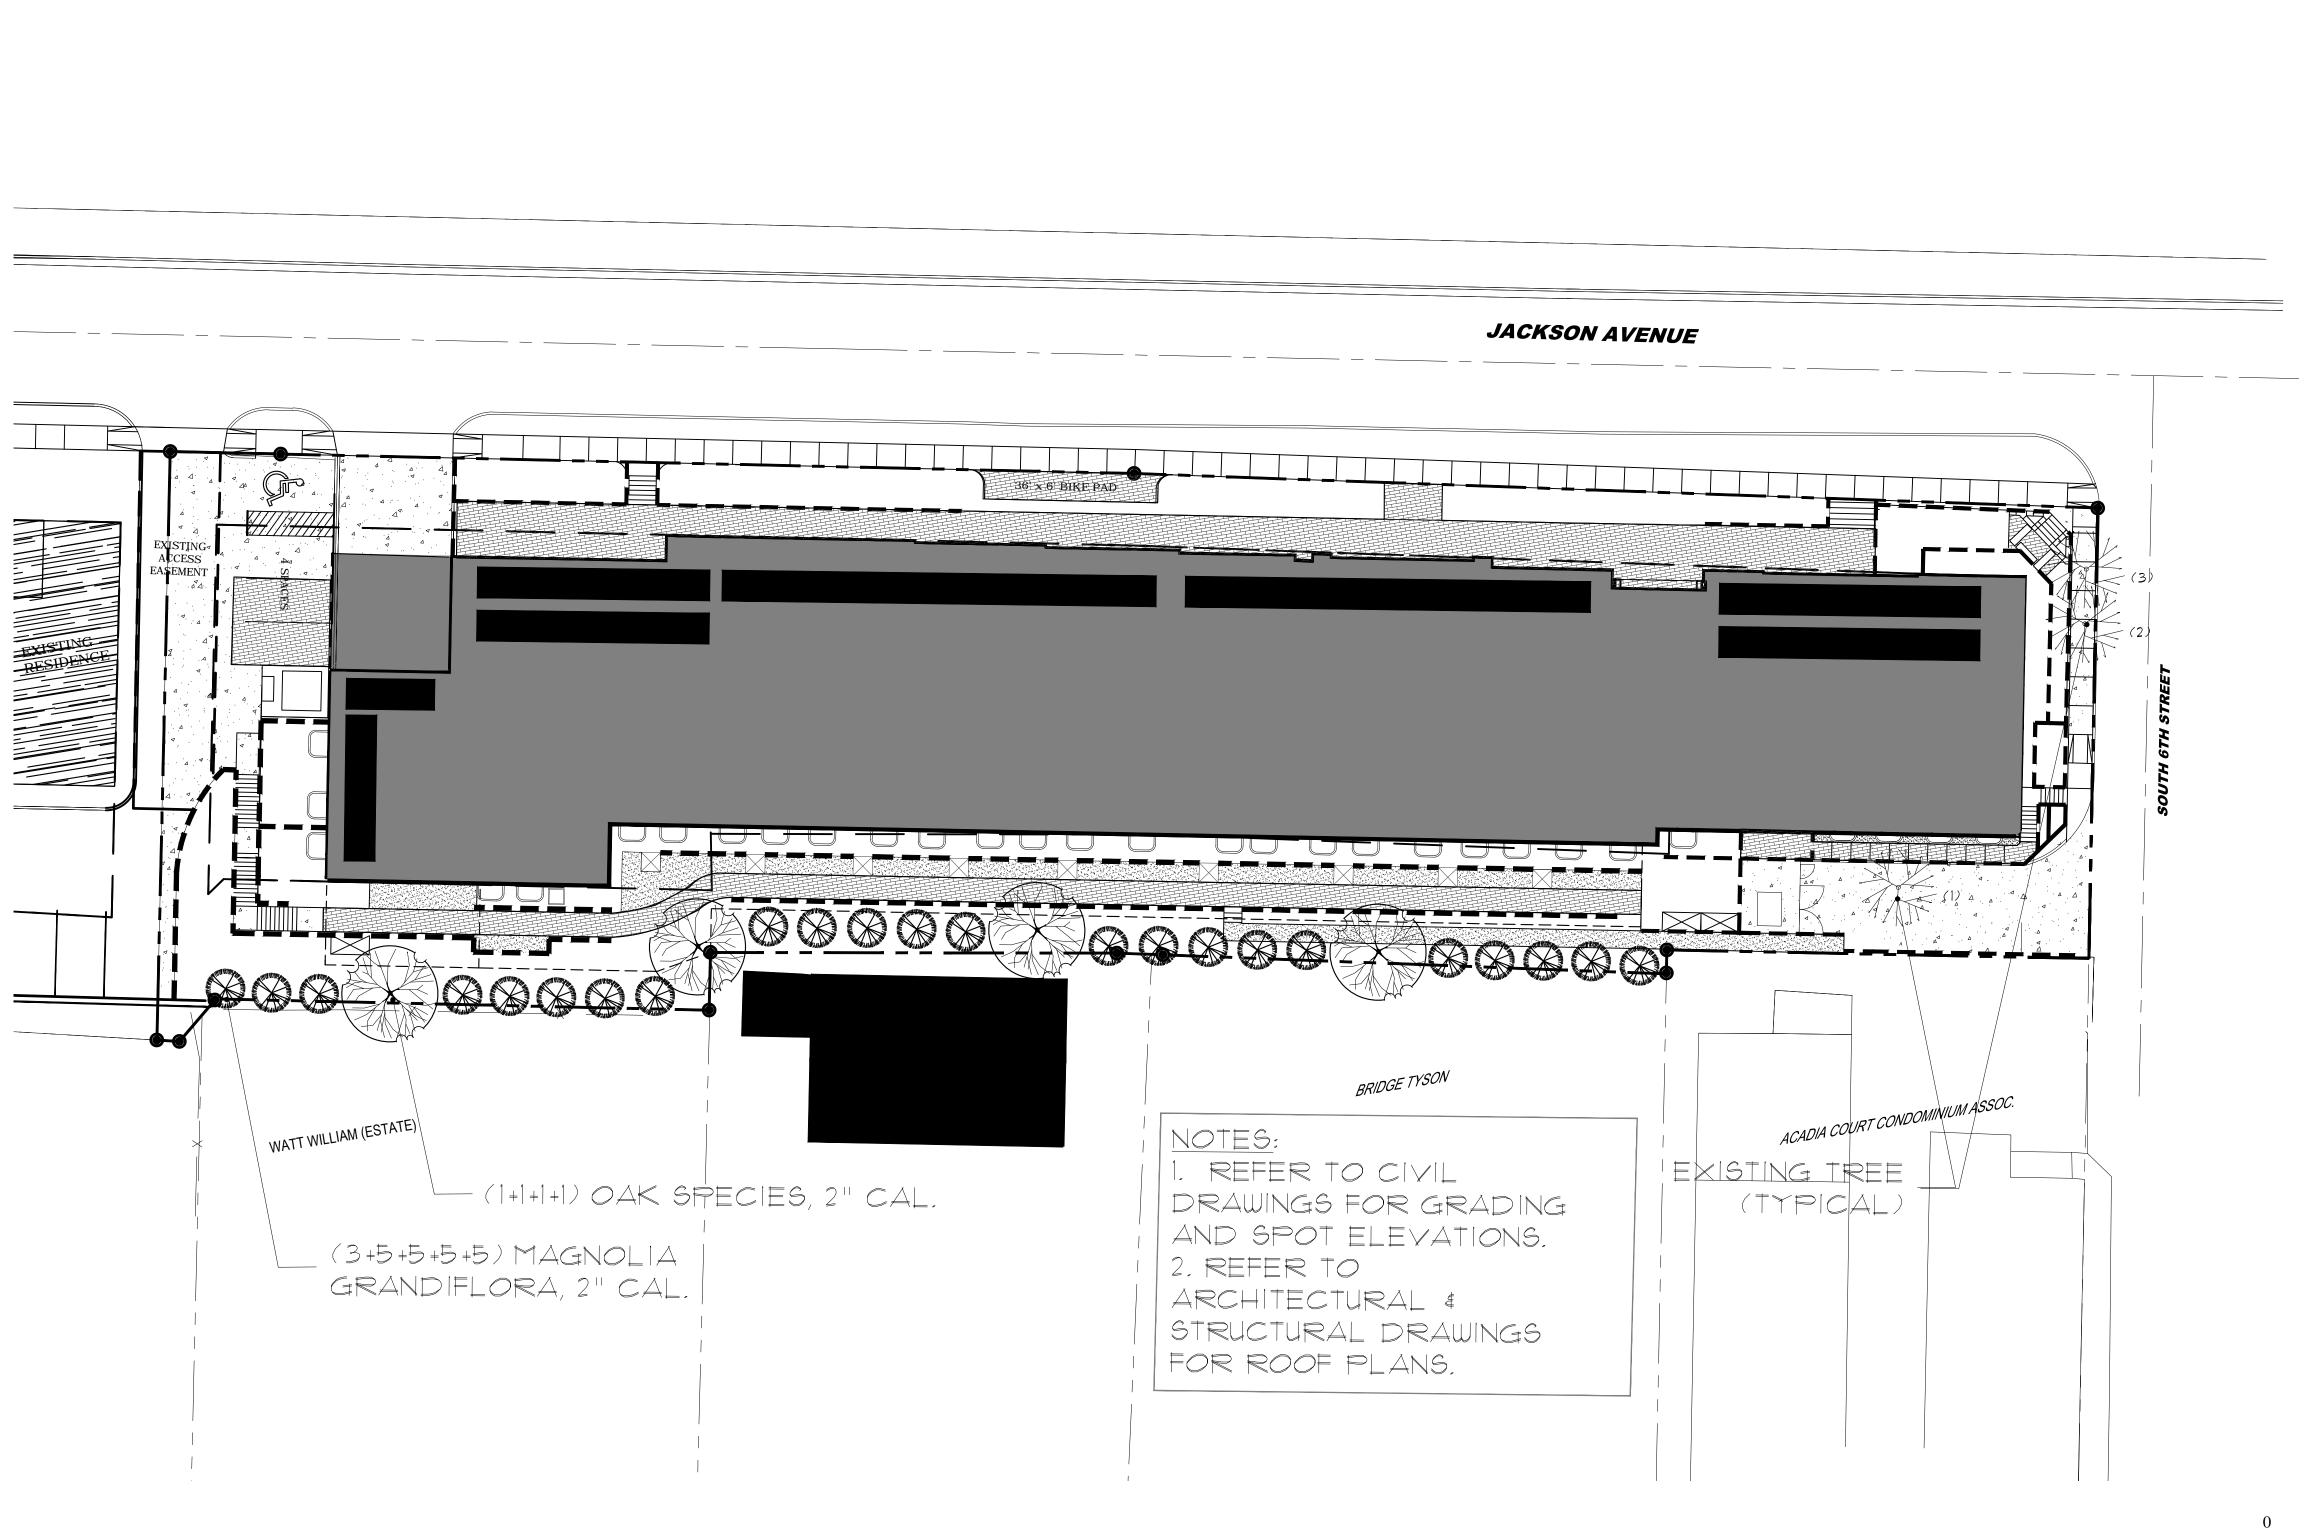

EXISTING TREE SURVEY:

NOTE: EXISTING TREES ARE SHOWN FOR THE PROPOSED HILTON HOME 2 SUITES SITE ONLY. NO TREE INFORMATION FOR LOTS 2 & 3 IS PROVIDED.

TREE NO. TREE TYPE SIZE

1 OAK 36" DBH \*

2 CEDAR 24" DBH \*

3 OAK 18" DBH

\* DENOTES HERITAGE TREE PER CITY OF OXFORD

\* DENOTES HERITAGE TREE PER CITY OF OXFORD LAND DEVELOPMENT CODE CHAPTER 34, ARTICLE II, SEC. 34.21.

PART I: EXISTING SIGNIFICANT & HERITIAGE TREE MITIGATION CALCULATION:

SIGNIFICANT TREES:

QTY DBH IN INCHES

QTY DBH IN INCHES SUBTOTAL

1 18 18

MITIGATED IN INCHES: 18 INCHES

10% EXEMPTION: 1.8 INCHES

5% RATE OF MITIGATION: 3.24 INCHES

EXISTING HERITIAGE TREE MITIGATION CALCULATION:

CALCULATION

HERITAGE TREES:

 QTY
 DBH IN INCHES
 SUBTOT,

 1
 36
 36

 1
 24
 24

TOTAL OF HERITAGE TREES TO BE MITIGATED
IN INCHES: 60 INCHES

10% EXEMPTION: 6.0 INCHES

2% RATE OF MITIGATION: 21 INCHES

COMBINED TOTAL OF MITIGATION: 21.0 INCHES

PART 2: CREDIT:

TY DBH IN INCHES SUBTOTAL

COMBINED TOTAL TO BE CREDITED
IN INCHES:

Ø INCHES

DIVIDED BY 5% RATE OF MITIGATION

NUMBER OF 2" TREE TO BE CREDITED: Ø TREES

PART 3: PLANTING REQUIREMENTS:

MITIGATION (PART 1) SUBTOTAL: 48.06 INCHES

CREDIT (PART 2): 0 INCHES


MITIGATION TOTAL: 27

TREES PROVIDED: 21 TREES
INCHES PROVIDED: 54.0 INCHES

EXISTING TREE SURVEY & TREE MITIGATION PLAN

SCALE: 1" = 20'-0"



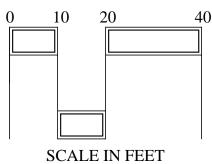

ANDSCA PROBLEM ROBATION OF MISSISSING

NDSCAPE ARCHITECT

1. BOX 157 - OXFORD, MS 38

(662) 236 - 3377

LANDSCAPE A

P.0. BOX 157 - OX

JACKSON ROW DEVELOPMEN

61 N. CLARK AVE SUITE 4900 HICAGO, IL 60601

PROJECT NO.: 15-1003

SCALE: 1" = 20' - 0"

DATE: 10/28/2015

FILE:

DRAWN BY: MRC


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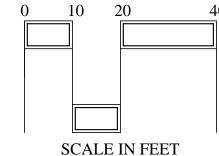
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SHEET

L-100



NORTH

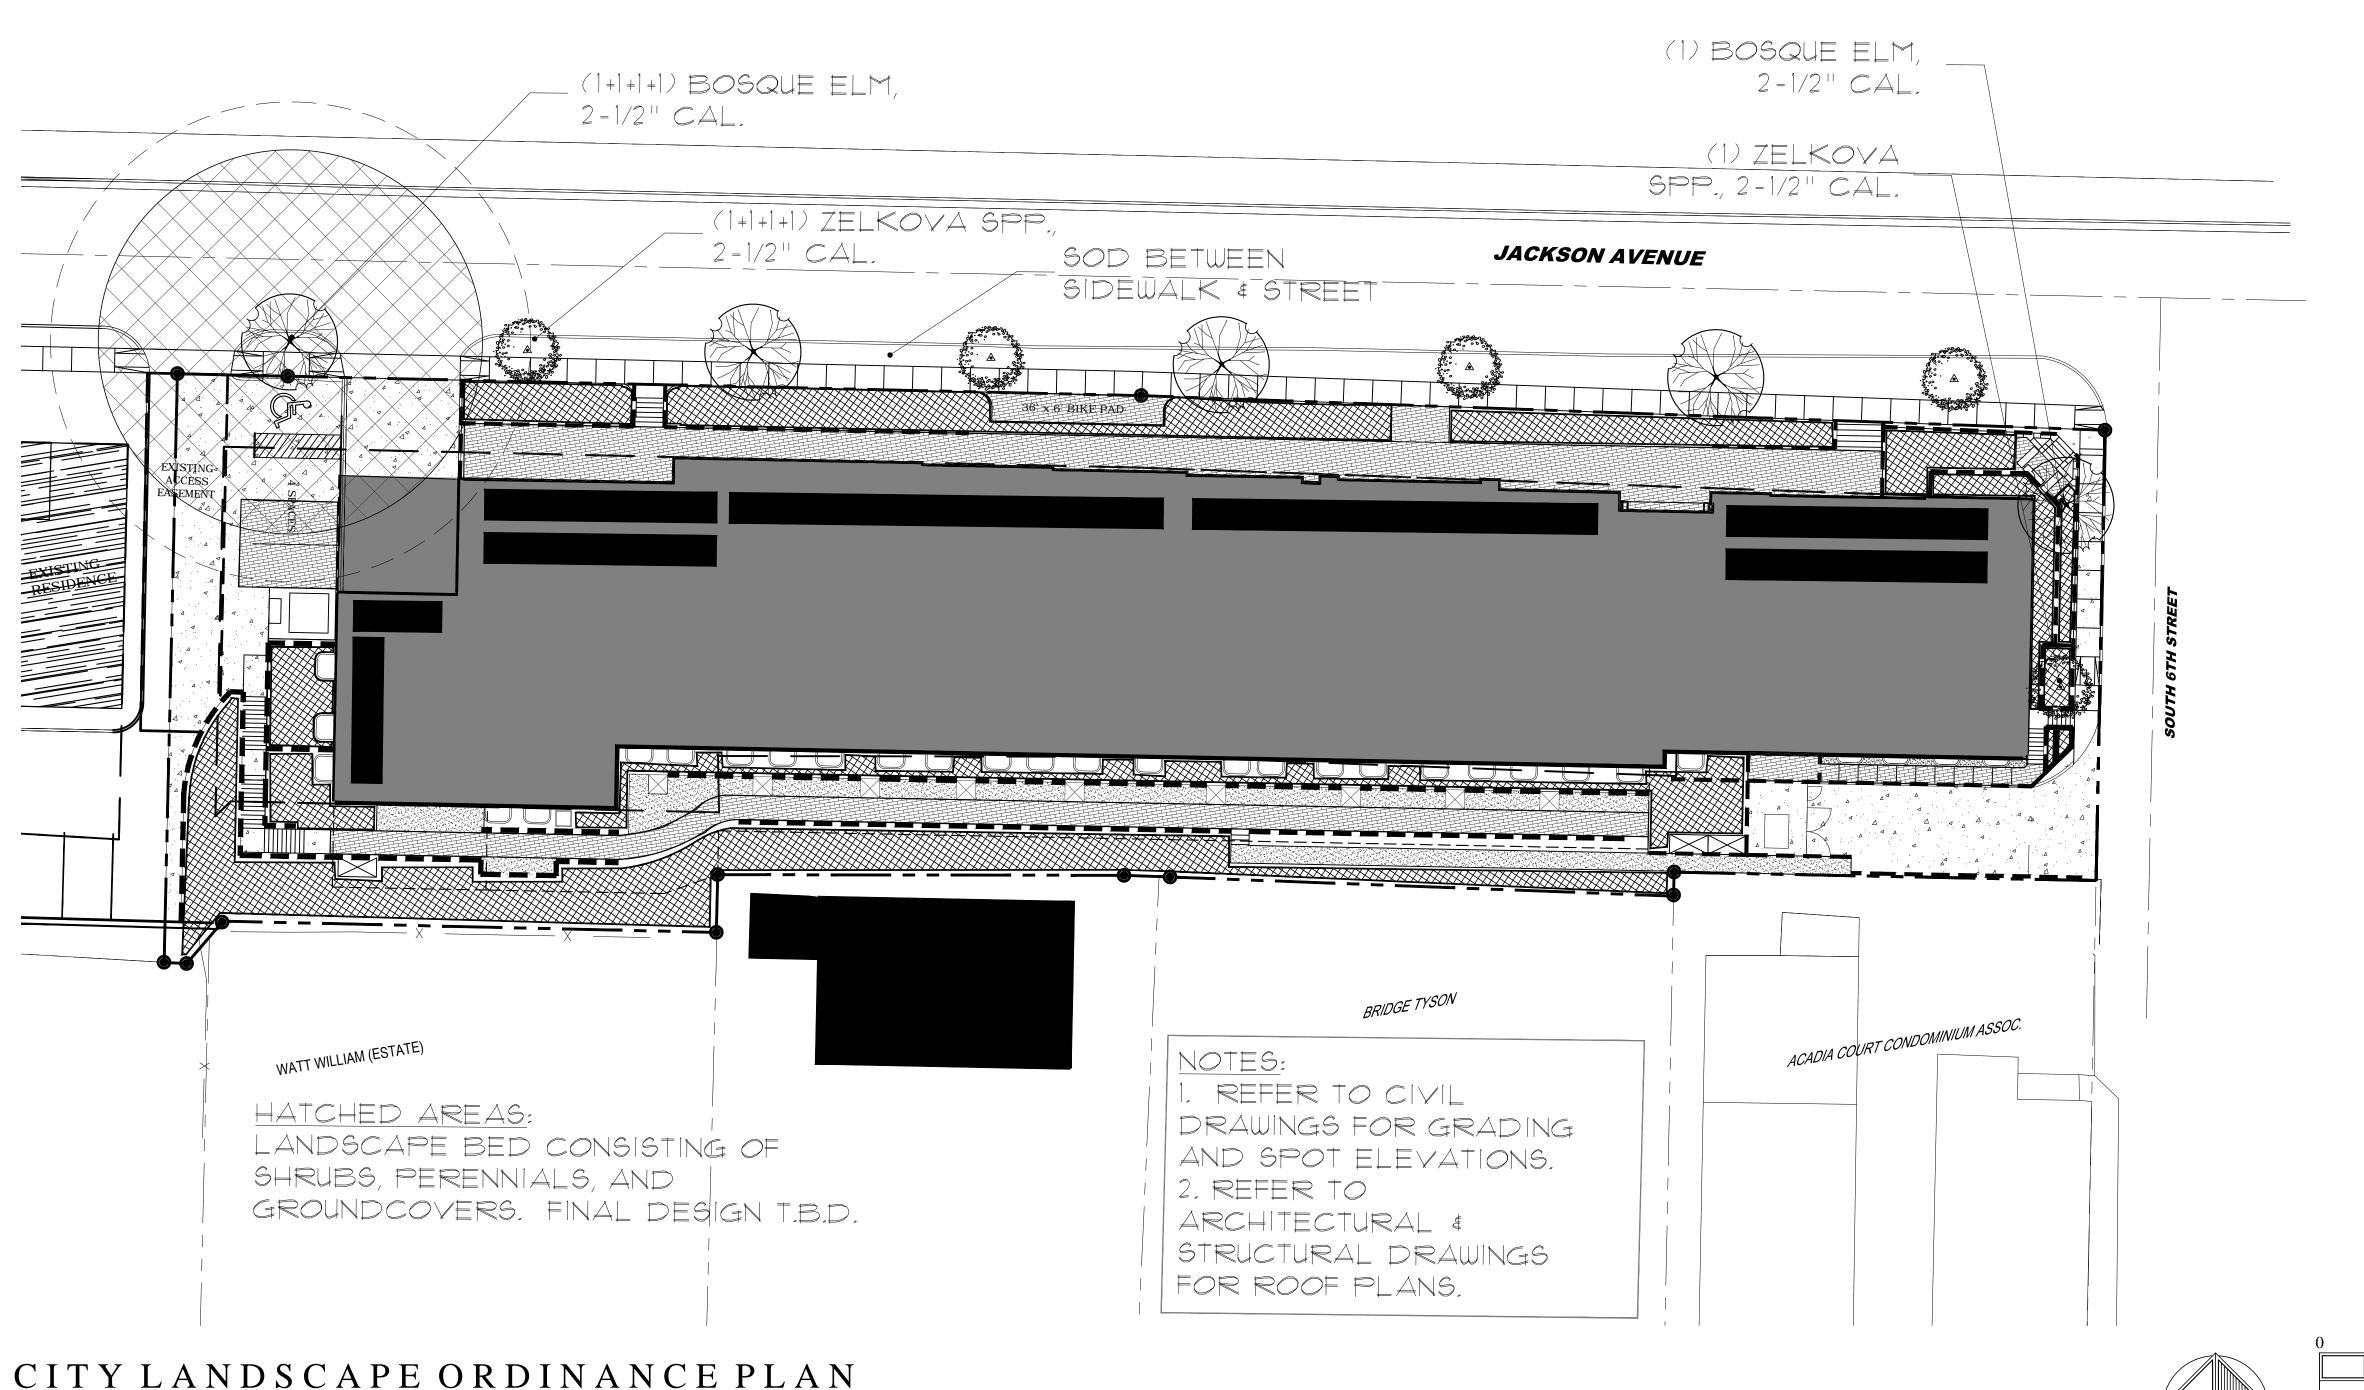

## GENERAL PLANTING NOTES:

- 1. EXISTING CONDITIONS INFORMATION IS BASED ON SITE PLAN PROVIDED BY PRECISION ENGINEERING AND HUMPHREYS & PARTNERS ARCHITECTS ON SEPTEMBER 14, 2015. INFORMATION IS FOR REFERENCE ONLY. EXISTING CONDITIONS SHOWN ON CONSTRUCTION DOCUMENTS MAY NOT BE ACCURATE AND/OR TRUE TO SCALE. FIELD VERIFY PRIOR TO CONSTRUCTION.
- 2. IN THE EVENT DISCREPENCIES ARISE BETWEEN EXISTING CONDITIONS SHOWN ON CONSTRUCTION DOCUMENTS AND EXISTING CONDITIONS IN THE FIELD, CONTACT LANDSCAPE ARCHITECT, MRC LANDSCAPE ARCHITECTURE AT 662-236-3377.
- 3. CONTRACTOR TO PROVIDE ANY AND ALL NECESSARY EROSION CONTROL (I.E., SILT FENCE, CHECK DAMS, TEMPORARY SEEDING) TO PREVENT SILT AND RUNOFF FROM EXITING PROJECT SITE UNTIL PERMANENT GRASSING AND/OR SOD HAS BEEN ESTABLISHED ON ANY DISTURBED GROUND.
- 4. CONTRACTOR TO STAKE OUT ALL PROPOSED TREE LOCATIONS, TURF AREAS, AND PLANTING BED AREAS FOR REVIEW AND APPROVAL BY LANDSCAPE ARCHITECT AND OWNER PRIOR TO CONSTRUCTION.
- 5. CONTRACTOR TO TIE ALL PROPOSED GRADING INTO EXISTING GRADES AT A MAXIMUM OF A 3:1. CONTRACTOR TO PROVIDE POSITIVE DRAINAGE AWAY FROM ALL STRUCTURES CONTRACTOR SHALL PROVIDE POSITIVE DRAINAGE TO PREVENT PONDING OF SURFACE RUNOFF ON PROPOSED PAVEMENT AND/OR TURF AND LANDSCAPE AREAS.
- 6. CONTRACTOR TO PROVIDE PERMANENT GRASSING OF ANY DISTURBED AREAS UPON COMPLETION OF CONSTRUCTION OPERATIONS. CONTRACTOR IS RESPONSIBLE FOR ANY EROSION REPAIRS AND/OR RE-GRASSING OF DISTURBED AREAS UNTIL A PERMANENT STAND OF GRASS HAS BEEN ESTABLISHED. REFER TO THE MISSISSIPPI DEPARTMENT OF TRANSPORTATION (MDOT) MISSISSIPPI STANDARD SPECIFICATIONS FOR ROAD AND BRIDGE CONSTRUCTION 2004 EDITION FOR GRASSING SPECIFICATIONS IF SOD OR SEEDING IS NOT SPECIFIED ON PLANTING PLAN.
- 1. CONTRACTOR TO PROVIDE ANY AND ALL NECESSARY TEMPORARY FACILITIES (I.E., WASTE DISPOSAL, PORT-O-LET, TRAFFIC CONTROL, EROSION CONTROL) NECESSARY FOR THE CONSTRUCTION OF THIS PROJECT.
- 8. ALL EXISTING SOD LOCATED WITHIN AREAS INDICATED AS PROPOSED PLANTING BED AREAS TO BE CUT OUT WITH MECHANICAL OR MANUAL OPERATED SOD CUTTER. EXISITNG SOD TO BE RELOCATED TO AREAS IN YARD AS DESIGNATED BY OWNER AND/OR LANDSCAPE ARCHITECT IF APPLICABLE.
- 9. ALL PLANTING BEDS TO BE AMENDED WITH A PLANTING MIX CONSISTING OF EQUAL PARTS OF ONE-THIRD (1/3) EXISTING SOIL OR CLEAN OFF-SITE TOPSOIL, ONE THIRD (1/3) CLEAN SAND, AND ONE THIRD (1/3) COMPOSTED PINE BARK FINES FOR CLAY SOILS OR ONE THIRD (1/3) PEAT MOSS, COMPOSTED COTTON BURR, OR HUMUS FOR SANDY SOILS. ALL OTHER SOIL AMENDMENTS TO BE ADDED AT RATES RECOMMEND BY SOILS REPORT. CONTRACTOR SHALL BE RESPONSIBLE FOR SOILS TEST AND REPORT AND SHALL REPORT FINDINGS TO LANDSCAPE ARCHITECT AND/OR
- 10. MULCH: AL PLANTING BEDS AND TREE MULCH RINGS TO BE MULCHED WITH A THREE (3) INCH LAYER OF DOUBLE-HAMMERED HARDWOOD MULCH. MULCH COLOR: CHOCOLATE BROWN. FOR SLOPES OVER 4:1, AREAS TO BE MULCHED WITH LONG LEAF OR SLASH PINE STRAW MULCH.
- 11. ALL SINGLE TRUNK TREES TO HAVE ONE (1) TREEGATOR TWENTY (20) GALLON CAPACITY INSTALLED. ALL MULTI-TRUNK TREES AND/OR EVERGREEN TREES TO HAVE ONE (1) TREE GATOR JR FIFTEEN (15) GALLON CAPACITY INSTALLED. BAGS ARE TO BE REMOVED AFTER ONE (1) COMPLETE GROWING SEASON AND GIVEN TO OWNER FOR FUTURE USE AS NEEDED.
- 12. PRE-EMERGE: ALL PLANTING BEDS TO BE TREATED WITH A GRANULAR PRE-EMERGENT HERBICIDE (1.E., SNAPSHOT, RONSTAR, ETC.) AT MANUFACTURER'S RECOMMENDED APPLICATION RATES. PRE-EMERGENT HERBICIDE SHALL BE APPLIED AFTER PLANTING BEDS HAVE BEEN MULCHED.
- 13. WARRANTY: LANDSCAPE CONTRACTOR SHALL PROVIDE A WARRANTY ON ALL PLANT MATERIALS AND WORKMANSHIP FOR NOT LESS THAN ONE (1) CALENDAR YEAR FROM THE DATE OF FINAL ACCEPTANCE.

N. CLARK AVE SUITE 4900 SAGO, IL 60601 161 N. SU CHICA


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PROJECT NO.:	15-1003
SCALE:	1" = 20' - 0"
DATE:	10/28/2015
FILE:	
DRAWN BY:	MRC
CHKD. BY::	MRC
REVISIONS:	

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SHEET



TREE PLANTING DETAIL

SCALE: N.T.S.

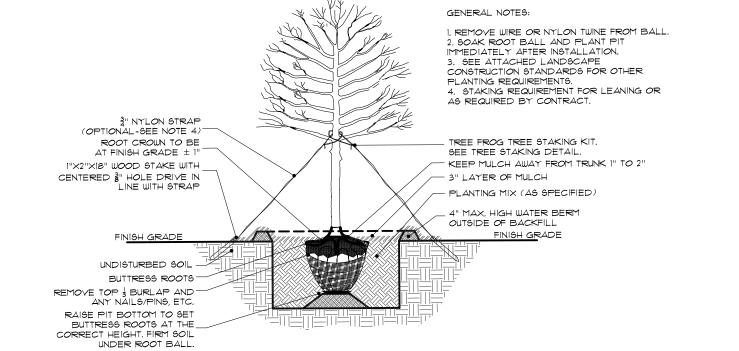SCALE: 1" = 20'-0"


SHRUB PLANTING DETAIL

SCALE: N.T.S.

# ROOT CROWN TO BE AT FINISH GRADE $\pm$ 1" KEEP MULCH AWAY FROM TRUNK 1" TO 2" - 4" LAYER OF MULCH — PLANTING MIX (AS SPECIFIED) OUTSIDE OF BACKFILL UNDISTURBED SOIL RAISE PIT BOTTOM TO SET ROOT BALL AT THE CORRECT \_ HEIGHT. FIRM SOIL UNDER ROOT BALL.

GENERAL NOTES:

1. REMOVE WIRE OR NYLON TWINE FROM BALL.
2. SOAK ROOT BALL AND PLANT PIT
IMMEDIATELY AFTER INSTALLATION.
3. SEE ATTACHED LANDSCAPE
CONSTRUCTION STANDARDS FOR OTHER
PLANTING REQUIREMENTS.

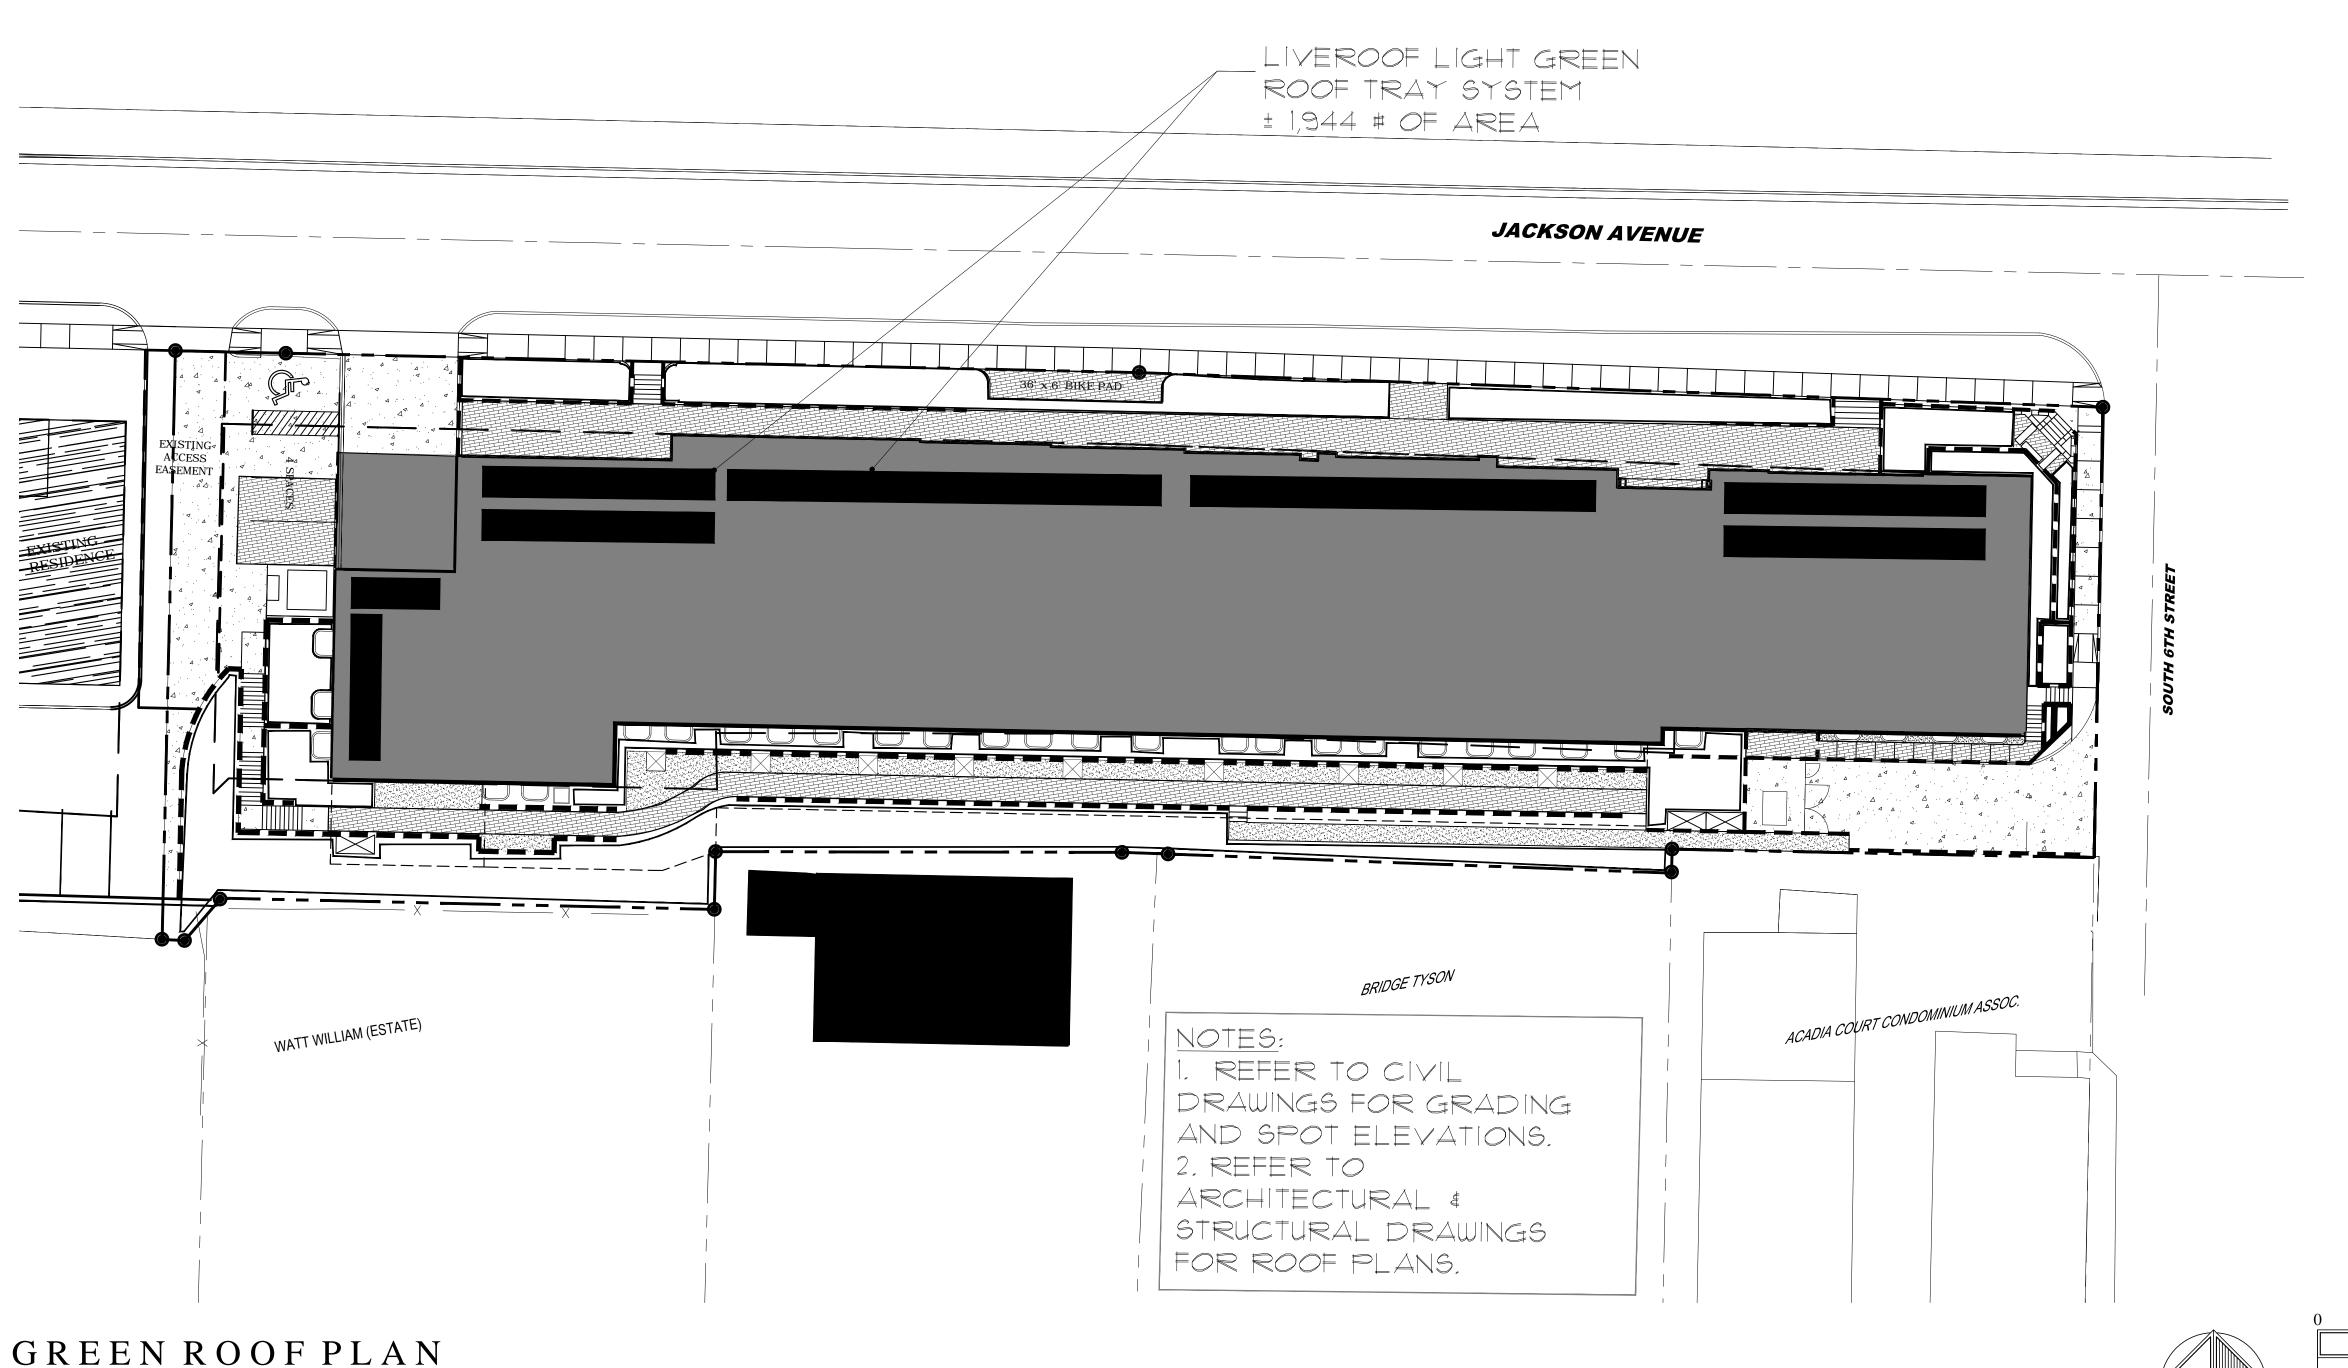

GREEN ROOF PLANTING NOTES:

GREEN ROOF BASIS OF DESIGN IS LIVEROOF LIGHT GROWN BY SOUTHEAST GREEN ROOFS

Each LiveRoof module to be pre-vegetated with 2 Sedum takesimense 'Gold Carpet' rooted plugs and I Allium cernuum bare root division as the base layer. Additional succulent species grown in as cuttings to include the Southeast Green Roofs Low Maintenance Mix which has been tested and selected for the Southeastern U.S. including Mississippi.

SEGR Low Maintenance Mix includes but is not limited to:

Sedum spurium  $\frac{1}{2}$ 'Green Mantle $\frac{1}{2}$ ' Sedum floriferum  $\frac{1}{2}$ 'Weihenstephaner Gold $\frac{1}{2}$ ' Sedum spurium  $\frac{1}{2}$ 'Dark Dragon $\frac{1}{2}$ ' Sedcum reflexum  $\frac{1}{2}$  'Sunsplash $\frac{1}{2}$ ' Sedum ellacombianum Sedum sexangulare ½ 'Elatum½' Sedum album ½'Murale½'

All LiveRoof modules to be custom grown by Southeast Green Roofs, LLC and delivered to certified LiveRoof Installers for installation and maintenance. LiveRoof modules shall be fully rooted and vegetated to a minimum of 95% fully rooted vegetative coverage.


REEN ROOF PI

38655

PROJECT NO.:	15-1003
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DATE:	10/28/201
FILE:	
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CHKD. BY::	MRC
REVISIONS:	


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GREEN ROOF PLAN

SCALE: 1" = 20'-0"

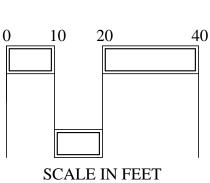

LOT COVERAGE NOTES & CALCULATIONS:

GREEN ROOF TRAYS (PERMEABLE)

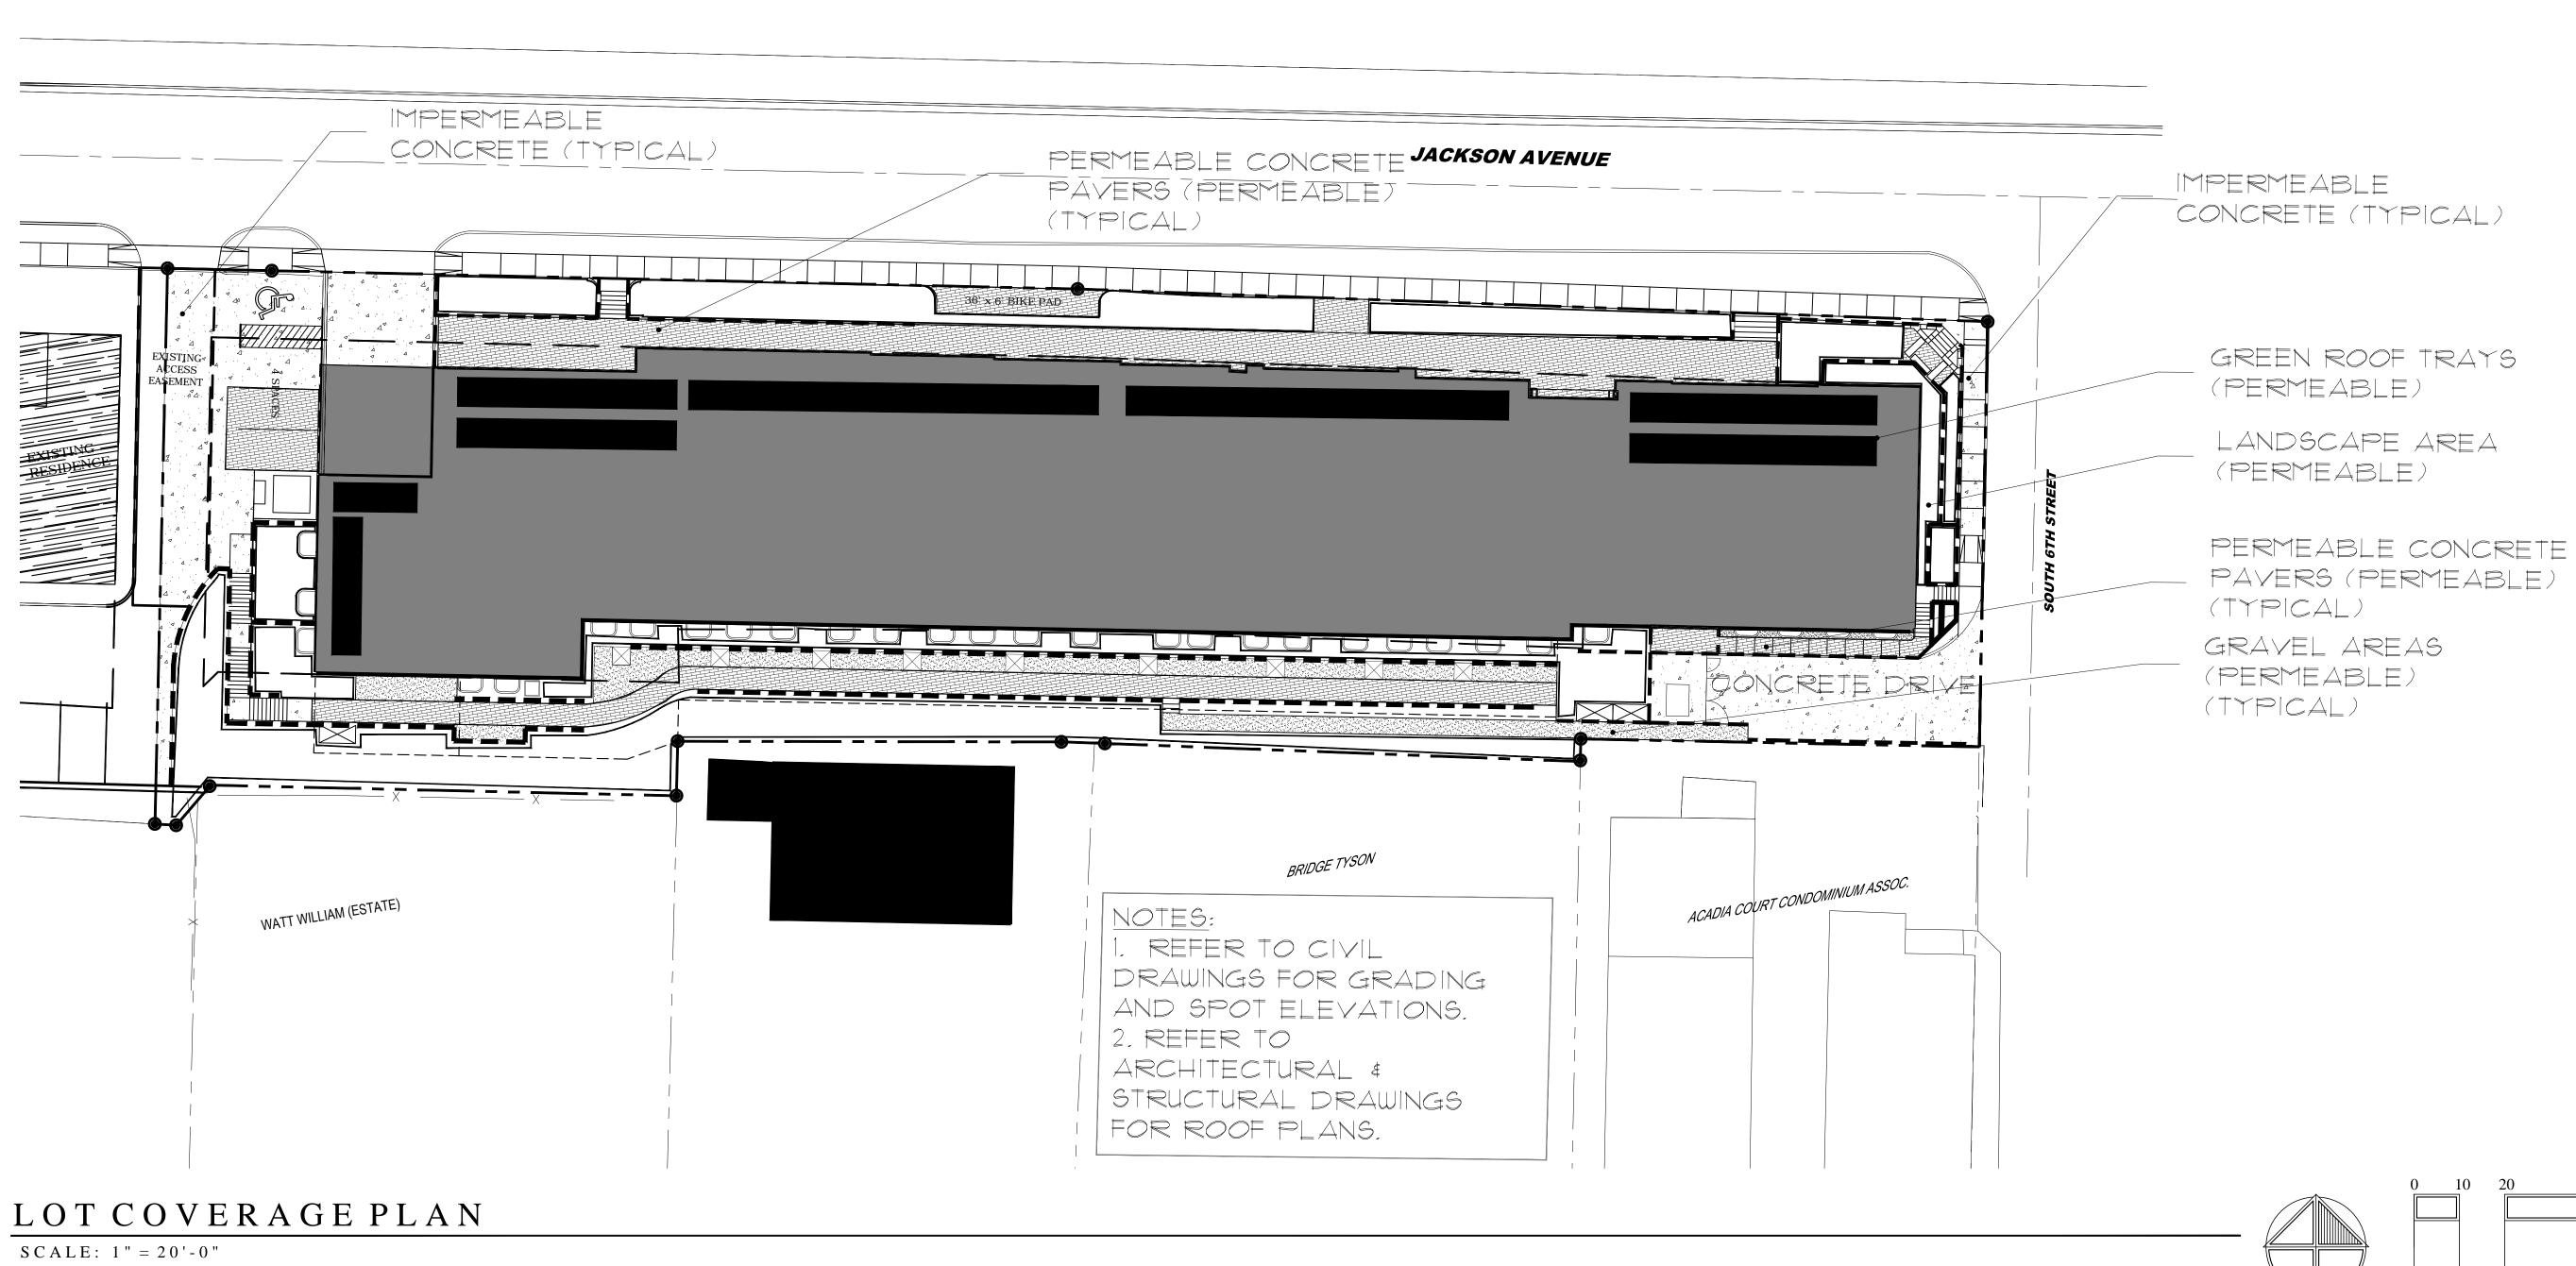LANDSCAPE AREA (PERMEABLE)

> PERMEABLE CONCRETE PAVERS (PERMEABLE)

GRAVEL AREAS (PERMEABLE)

> CONCRETE (IMPERMEABLE)


TOTAL LOT AREA: 41,469.3 SQ. FT.

TOTAL IMPERVIOUS AREA: 25,206 SQ. FT.

TOTAL PERVIOUS AREA: 16,263.3 SQ. FT.

LOT COVERAGE: 60%



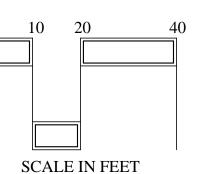

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PROJECT NO.:	15-1003
SCALE:	1" = 20' - 0"
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